#### meeting minutes

#### **BRAY PROJECT NUMBER | 3495**

Client Name Mercer County School District

Project Name District-Wide Master Plan

Project Location Aledo, IL

Meeting Date September 6, 2022

Meeting Location Mercer County Intermediate School

#### Attendees:

Mercer County School District

Scott Petrie Bill Smock Mike Brown Bill Fleuette Tab Balmer Don Yates Mark Bieri **Bray Architects** 

Mark Miller – Project Architect Nick Woodard – Project Architect

Reported By: Bray Architects

**Purpose of Meeting:** Mercer County School District and Bray Architects met to discuss the district-wide master plan.

**Overall Summary:** Mercer County School District and Bray Architects met to review and discuss the results of the possible solution options proposed strategy for the district-wide master plan.

#### **Meeting Minutes**

Item	Description
1.0	New Boston Elementary
1.1	Nick presented updated plans for New Boston, incorporating revisions discussed at the last meeting.
1.2	Mark discussed the need for the District to have any existing asbestos abated, including in areas of New Boston that will be demolished.
1.3	The group discussed the proposed remodeling of the entry vestibule in the 1999 addition to include a controlled entry and decided not to proceed with the modifications. The entry is to remain as-is, with possible modifications to the exterior camera security system.

1.4	The existing Library in the 1999 addition is to be remodeled to be three SPED classrooms, with an exterior window added so that each classroom has a window.
1.5	The existing Multi-Purpose Room is to be remodeled to be two 1st Grade Classrooms with a sink and storage casework.
1.6	The Group discussed the need to accommodate assembly functions in the Gymnasium with retractable bleachers.
1.7	Lockers are to be included in corridors, single tier, no locks are needed.
1.8	The Group reviewed and discussed a plan provided by Marcus which included additional offices and a conference room. Marcus to provide a detailed list of requested additional spaces not currently shown on the New Boston plan.
2.0	Apollo Elementary
<b>2.0</b> 2.1	Apollo Elementary  Nick presented progress plans and images of the Pre-K addition and Multi-Purpose Room addition.
	Nick presented progress plans and images of the Pre-K addition and Multi-Purpose Room
2.1	Nick presented progress plans and images of the Pre-K addition and Multi-Purpose Room addition.  The Pre-K classrooms include single stall Toilet Rooms. Additional sinks outside the Toilet Rooms are not required. A wardrobe for teachers is to be included in classroom

The above information is the interpretation of the meeting activities and comments; and should be reviewed by all attendees. Please comment on any discrepancies and inform the writer as soon as possible of any changes required.

Date issued: Wenesday | September 7, 2022

Bray Associates Architects, Inc.

Niedword

Nick Woodard, AIA, LEED AP Architect

## SITE - OPTION 12 | NEW BOSTON ELEMENTARY







#### **GENERAL NOTES**

- DO NOT SCALE FROM DRAWINGS.
- EXISTING CONDITIONS: EXISTING CONDITIONS SHOWN ON DRAWINGS REPRESENT CURRENT BUILDING. IT IS THE RESPONSIBILITY OF THE CONTRACTOR TO FIELD VERIFY EXISTING CONDITIONS PRIOR TO PERFORMING WORK. REPORT ANY DISCREPANCIES TO THE ARCHITECT FOR REVIEW. WORK DONE WITHOUT RESOLUTION OF DISCREPANCIES MUST BE REDONE AT THE REQUEST OF THE
- REFER TO SHEET AG1.0 FOR WALL TYPES. REFER TO SHEET G0.1 FOR RATED
- REFER TO SHEE<mark>T</mark> AG1.0 FOR TYPICAL MOUNTING HEIGHTS. REFER TO INTERIOR ELEVATION SHEETS FOR ROOM SPECIFIC FIXTURE MOUNTING HEIGHTS.
- REFER TO SHEET A9.0 FOR FLOOR TRANSITION DETAILS.

ARCHITECT AT NO ADDITIONAL COST TO THE CONTRACT.

- REFER TO SHEET A9.0 FOR TYPICAL FLOOR/BASE CONDITIONS.
- DIMENSIONS FOR INTERIOR STUD WALLS ARE TO FACE OF WALL. EXTERIOR STUD WALLS ARE DIMENSIONED TO INTERIOR FACE OF STUDS. CMU WALLS ARE DIMENSIONED TO FACE OF WALL.
- HOUSEKEEPING PADS BY GENERAL CONTRACTOR. SEE PLUMBING, HVAC & ELECTRICAL DRAWINGS FOR LOCATIONS.
- REFER TO SHEET AG1.0 FOR TYPICAL FIRE EXTINGUISHERS CABINET DETAILS. FULLY RECESSED WHERE WALL DEPTH ALLOWS.
- IDENTIFY WITH PAINTED LETTERING "FIRE WALL" AND "FIRE BARRIER WALL" ABOVE CEILING AT 20'-0" O.C. MAX., BOTH SIDES OF WALL. SEE SHEET G0.1 PLANS FOR LOCATION OF RATED WALLS.
- REFER TO STRUCTURAL DRAWINGS FOR FIRE PROOFING LOCATIONS. PROVIDE INTUMESCENT PAINT AT EXPOSED STEEL COLUMNS. PROVIDE INTUMESCENT PAINT AT THE BOTTOM FLANGE OF STEEL LINTELS. PROVIDE SPRAY APPLIED FIRE PROOFING AT STEEL BEAMS, ROOF DECK AND ROOF JOISTS UNLESS NOTED OTHERWISE.
- REFER TO REFLECTED CEILING PLANS & CLERESTORY PLANS FOR LOCATION OF ALL WINDOW TREATMENTS.
- REQUIRED MEANS OF EGRESS FROM THE EXISTING BUILDING SHALL BE MAINTAINED AT ALL TIMES DURING CONSTRUCTION WHEN THE BUILDING REMAINS OCCUPIED. IN THE EVENT THAT AN EXISTING MEANS OF EGRESS CANNOT BE MAINTAINED, THE GENERAL CONTRACTOR SHALL PROVIDE AN APPROVED TEMPORARY MEANS OF EGRESS.

### KEYNOTE LEGEND



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REVISIONS: # DATE DESCRIPTION

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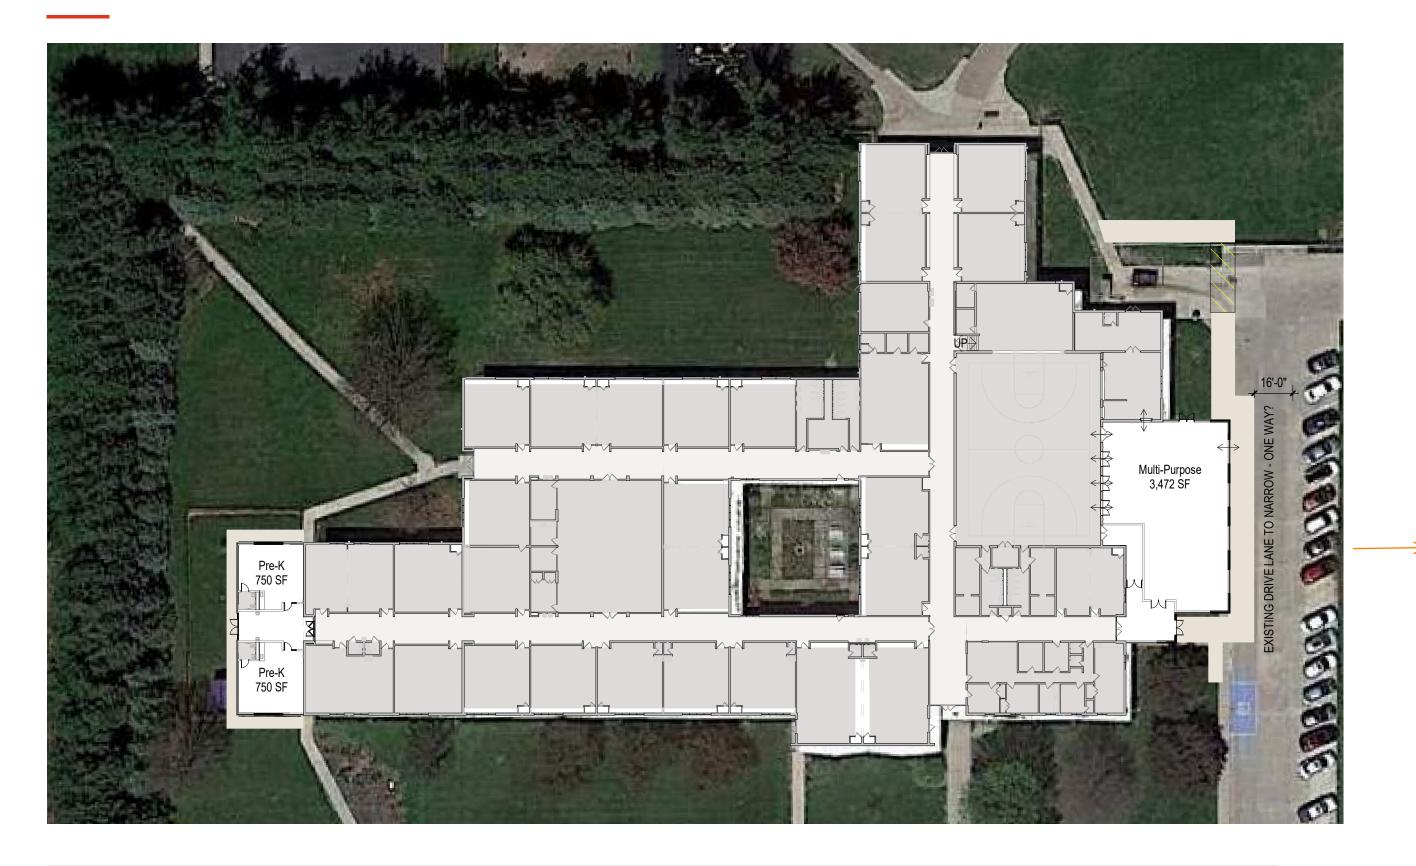
**OVERALL FIRST FLOOR PLAN** 


UNIT B

KEY PLAN

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## **OVERALL PLAN - SITE | Apollo Elementary School**





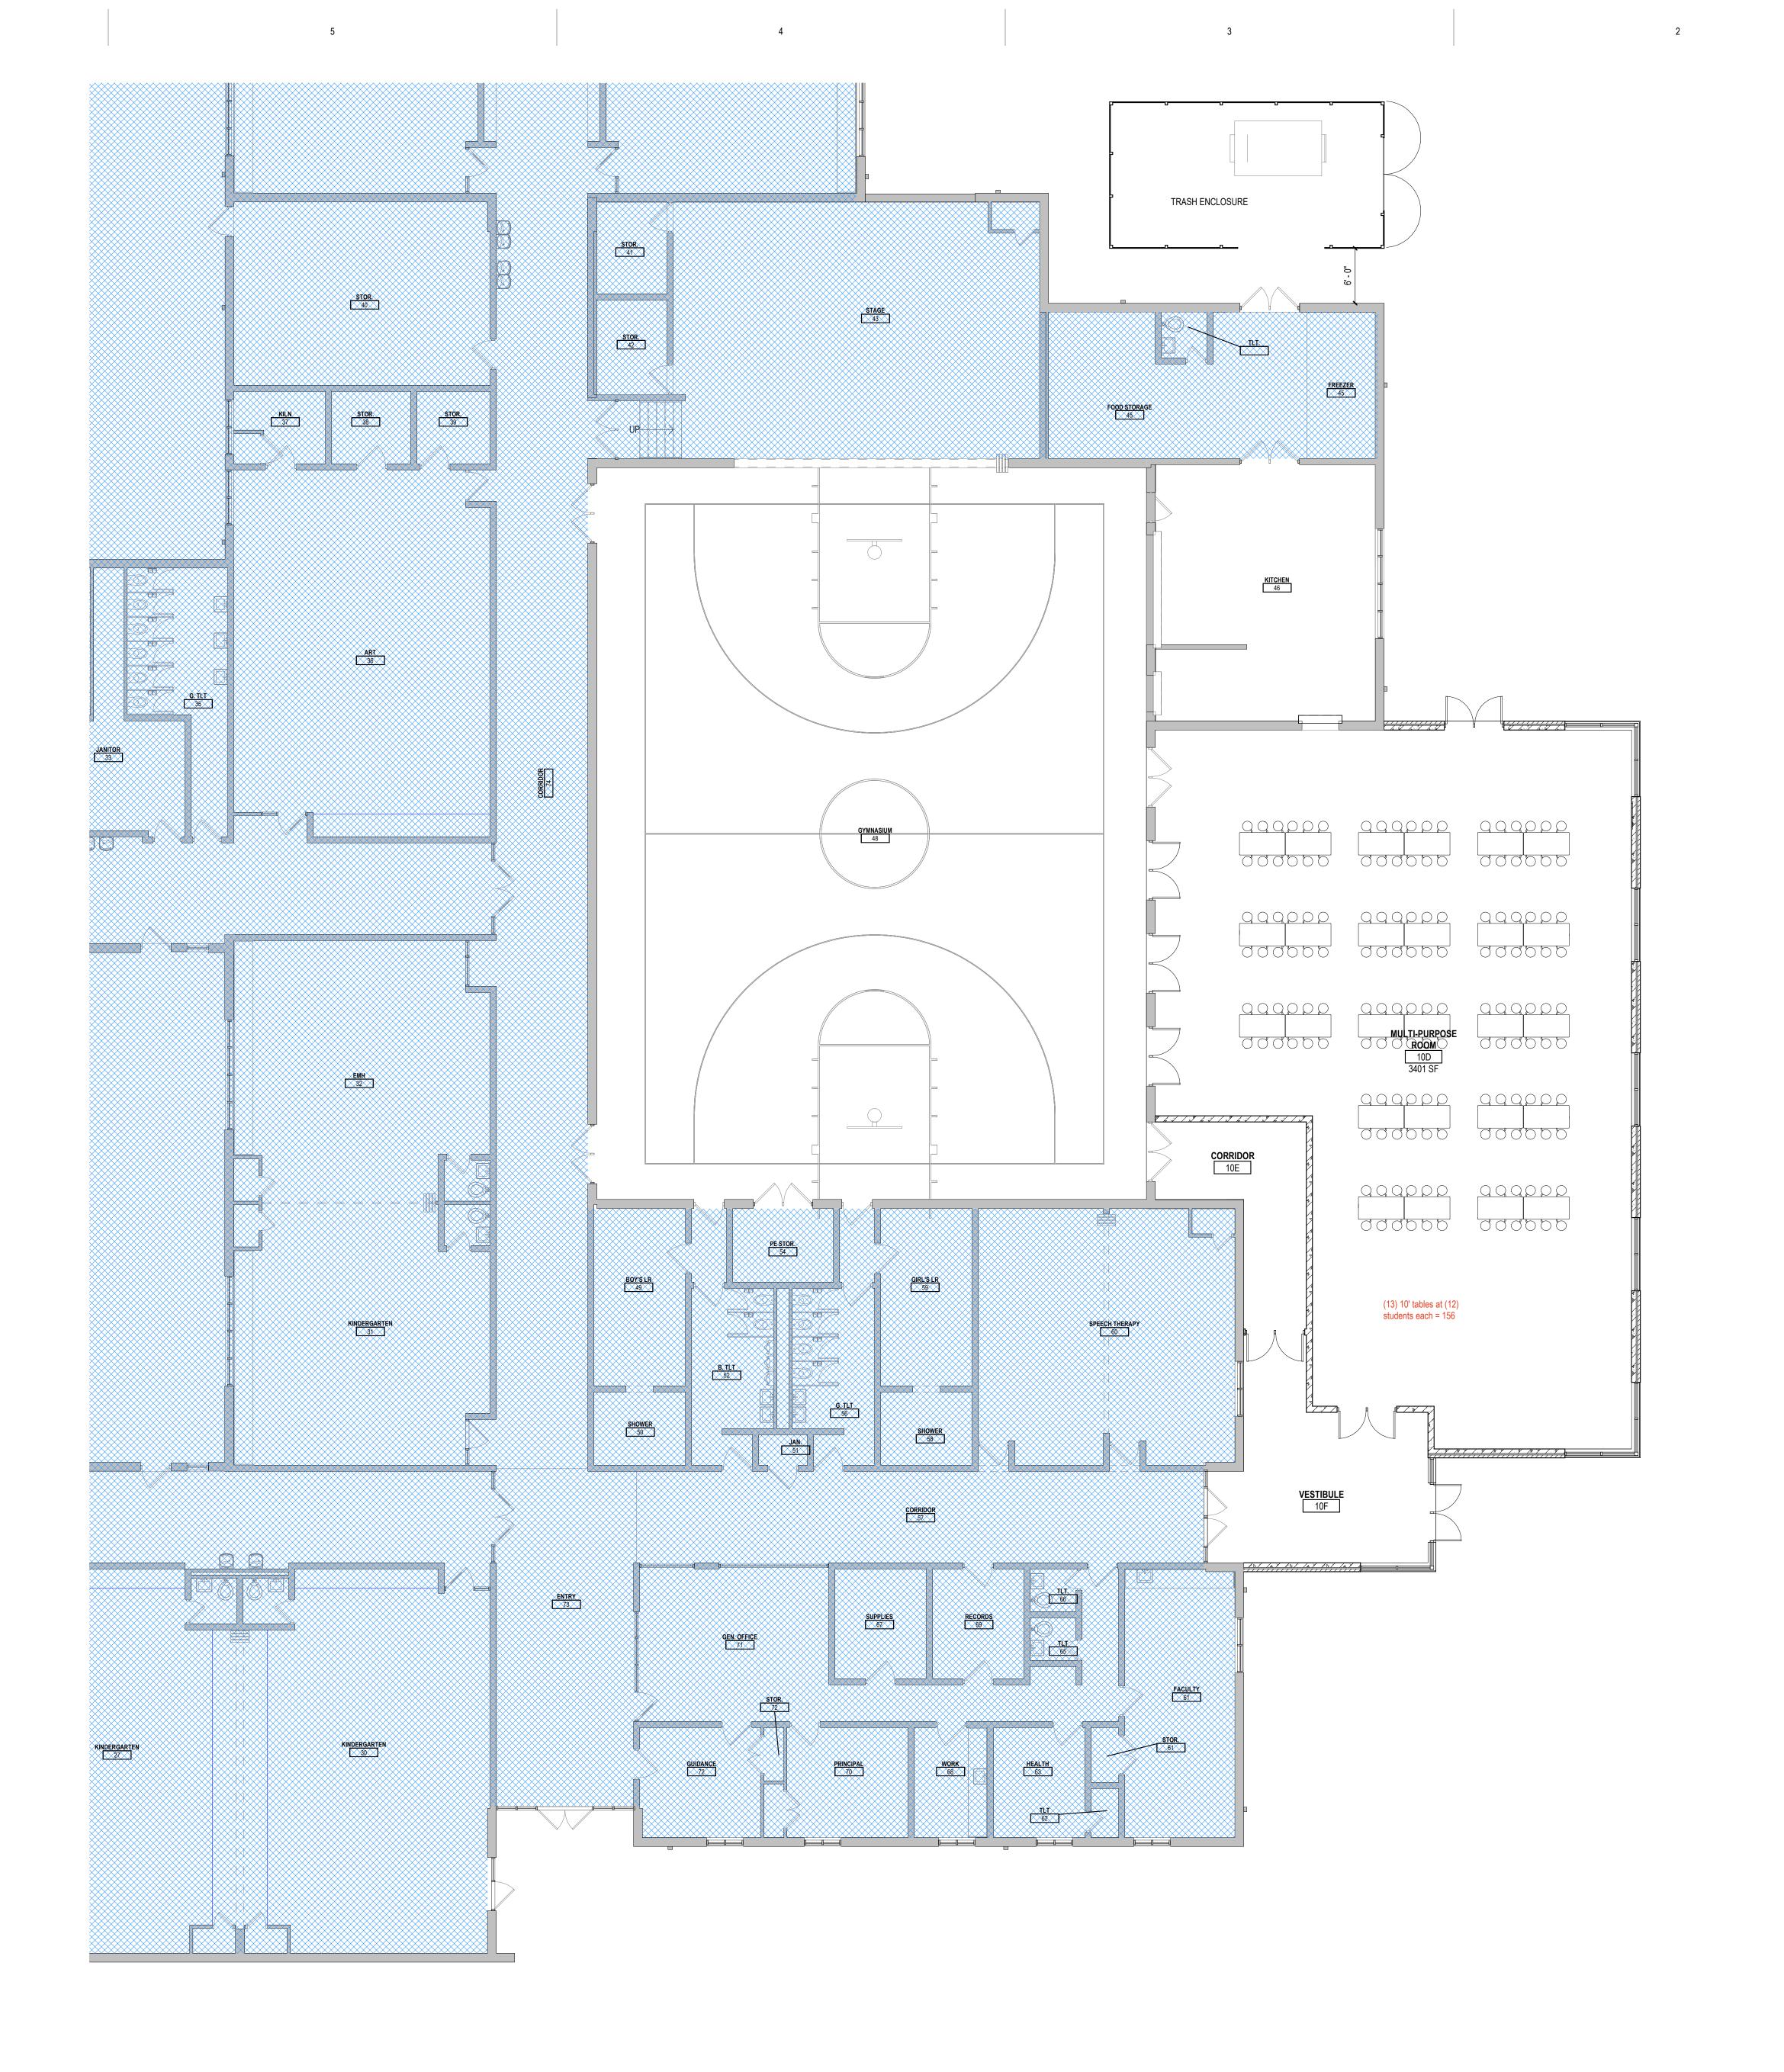

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## KEYNOTE LEGEND



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**UNIT B** 

A B

KEY PLAN



1 FIRST FLOOR PLAN - UNIT A

A-.-A Scale: 1/8" = 1'-0"

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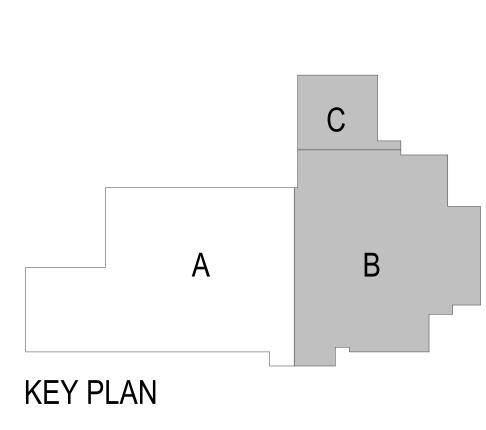
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Project Number: 3495

Issued For:

BID PACKAGE 1

7/28/2022 Sheet Title:

Sheet Title:
FIRST FLOOR UNIT A

Sheet Number:

A-.-A

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# SCHEMATIC DESIGN | MULTI-PURPOSE ROOM ADDITION | APOLLO ELEMENTARY





# SCHEMATIC DESIGN | MULTI-PURPOSE ROOM ADDITION | APOLLO ELEMENTARY





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